DUPAGE COUNTY PROPOSED LIGHTING PLANS

COUNTY HIGHWAY 21 FABYAN PARKWAY SECTION 22-00210-05-TL

FABYAN PARKWAY ROADWAY LIGHTING IMPROVEMENTS


R 09 E

GRAND PROVE

PROJECT LOCATION

PROJECT LOCATION



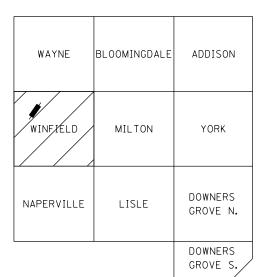

= = PROJECT LOCATION
DU PAGE COUNTY

C FMAN

ILLINOIS REGISTERED PROFESSIONAL ENGINEER NO. 062-046824

PLAN PREPARATION DATE: 04-18-2022

MY LICENSE EXPIRES ON 11-30-2023

PLANS PREPARED BY:



FOR

DUPAGE COUNTY
DIVISION OF TRANSPORTATION
CHRISTOPHER C. SNYDER, P.E.
COUNTY ENGINEER

COUNTY HIGHWAY 21 SECTION 22-00210-05-TL

INDEX OF SHEETS

1 COVER SHEET

HIGHWAY STANDARDS, GENERAL NOTES, AND SOQ


SCHEDULE OF QUANTITIES
PROPOSED LIGHTING PLANS

9 LIGHTING CIRCUIT DIAGRAM 10-18 DISTRICT 1 & HIGHWAY STANDARDS

PROJECT LOCATED IN THE CITY OF WEST CHICAGO

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FULL SIZE PLANS HAVE BEEN PREPARED USING STANDARD ENGINEERING SCALES. REDUCED SIZED PLANS WILL NOT CONFORM TO STANDARD SCALES. IN MAKING MEASUREMENTS ON REDUCED PLANS, THE ABOVE SCALES MAY BE USED.

J.U.L.I.E.
JOINT UTILITY LOCATING INFORMATION FOR EXCAVATORS
1-800-892-0123
OR 811

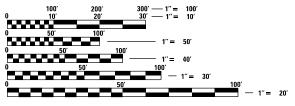GENERAL NOTES

- I. PROVIDE ALL LABOR, MATERIALS, AND EQUIPMENT TO FURNISH AND INSTALL THE ELECTRICAL WORK AS SHOWN ON THE PLANS, AS DETAILED IN THE SPECIFICATIONS, AS REQUIRED BY THE NATIONAL ELECTRICAL CODE AND AS REQUIRED FOR SPECIFIED OPERATION. CONTRACTOR SHALL EMPLOY ONLY EXPERIENCED ELECTRICIANS. A DULY LICENSED ELECTRICIAN SHALL SUPERVISE ALL WORK. CONTRACTOR SHALL ENSURE THAT ALL EMPLOYEES ARE FAMILIAR WITH THE TYPE OF WORK ENCOUNTERED ON THE PROJECT. ALL MATERIALS AND EQUIPMENT PROVIDED, WHERE APPLICABLE, SHALL HAVE A UL OR FM "LISTING MARK" AFFIXED TO THEM OR THEIR PACKING CONTAINERS AND THEY SHALL MEET ALL UR OF FM AND NEC (NATIONAL ELECTRICAL CODE) STANDARDS FOR THEIR INDICATED USE.
- WHEREVER THE TERM "STANDARD SPECIFICATIONS" IS USED, IT SHALL MEAN "STANDARD SPECIFICATIONS FOR ROAD AND BRIDGE CONSTRUCTION, 2022 EDITION BY THE ILLINOIS DEPARTMENT OF TRANSPORTATION." ELECTRICAL EQUIPMENT MATERIALS AND INSTALLATION SHALL BE ACCORDING TO STANDARD SPECIFICATION DIVISION 800 "ELECTRICAL." THE SPECIAL PROVISIONS AND THE PLANS. GENERAL ELECTRICAL REQUIREMENTS SHALL BE ACCORDING TO THE APPLICABLE ARTICLES IN SECTION 801 "ELECTRICAL REQUIREMENTS."
- FIELD LOCATING OF UTILITIES:

UTILITY LOCATIONS SHOWN ON THE DRAWINGS ARE FROM UTILITY COMPANY RECORDS AND MAY OR MAY NOT BE ACCURATE OR COMPLETE. THE CONTRACTOR SHALL VERIFY THE LOCATION OF ALL EXISTING UTILITIES BEFORE BEGINNING CONSTRUCTION AND SHALL PROTECT ALL UTILITY FACILITIES FROM DAMAGE AND DISRUPTION. THE CONTRACTOR SHALL REPAIR AND RESTORE ANY UTILITIES DAMAGED OR DISRUPTED DURING CONSTRUCTION OPERATIONS TO THE SATISFACTION OF THE UTILITY OWNER AT CONTRACTOR'S OWN EXPENSE

PRIOR TO POLE INSTALLATION, CONTRACTOR SHALL PHYSICALLY LOCATE ALL UTILITIES IN THE AFFECTED AREA, REGARDLESS OF THE OWNERSHIP OF THE UTILITY, JULIE LOCATING ALONE IS NOT SUFFICIENT. METHODS THE CONTRACTOR SHALL USE INCLUDE HAND DIGGING, VACUUM POTHOLING, PROBING, ELECTRONIC LOCATING USING CONTRACTOR'S OWN EQUIPMENT, VISUAL SURVEY OF NEARBY FACILITIES (MANHOLES, INLETS, STREET BOXES, HYDRANTS AND THE LIKE), CITY SEWER MAPS, IN SHORT: ANY METHOD DEEMED BY THE CONTRACTOR TO BE SUFFICIENT TO PREVENT ANY DAMAGE OR DISRUPTION TO EXISTING UTILITIES. FIELD LOCATING OF UTILITIES SHALL BE INCLUDED WITH THE ASSOCIATED PAY ITEM.

4. DETERMINING LIGHT POLE LOCATIONS:

INSTALL LIGHT POLES TO THE OFFSET SPECIFIED IN THE PLANS. TO ACHIEVE THIS CONSISTENT OFFSET THE CONTRACTOR SHALL LOCATE ALL UTILITIES AT THE PROPOSED LIGHT POLES, ACCORDING TO GENERAL NOTE 3. AFTER UTILITIES HAVE BEEN LOCATED, VERIFY PROPOSED LIGHT POLE OFFSETS TO ACHIEVE A CONSISTENT OFFSET. CONFIRM LIGHT POLE PLACEMENTS WITH THE COUNTY IN THE FIELD PRIOR TO INSTALLATION. DETERMINING LIGHT POLE LOCATIONS SHALL BE INCLUDED WITH THE PAY ITEM LIGHT POLE, WOOD, 50 FOOT, CLASS 4, WITH 15FT MAST ARM.

REPAIR OF DAMAGE:

PROVIDE REPAIRS TO ANY PUBLIC OR PRIVATE PROPERTY, INCLUDING UTILITIES WHICH ARE DAMAGED OR DISTURBED BY CONSTRUCTION OPERATIONS. REPAIRS SHALL BE PROVIDED AT CONTRACTOR'S OWN EXPENSE. WHERE UTILITY LINES, UNDERGROUND OBSTRUCTIONS OR PIPING MAY BE UNCOVERED BY CONSTRUCTION ACTIVITIES THE CONTRACTOR SHALL NOTIFY THE OWNER OF THE UTILITY AND TAKE ALL NECESSARY MEASURES TO PREVENT INTERRUPTION OF SERVICES THAT MAY BE DAMAGED OR INTERRUPTED THROUGH CONTRACTOR'S OPERATIONS AND PROVIDE IMMEDIATE REPAIR AND/OR RESTORATION AT THE CONTRACTOR'S OWN EXPENSE.

- ALL WIRING IN CONDUIT SHALL BE XLP-USE STRANDED COPPER ACCORDING TO STANDARD SPECIFICATION 1066, CABLE INSULATION SHALL BE SOLID COLOR-CODED RED, BLUE, WHITE OR GREEN ACCORDING TO USE. COLOR TAPE ON BLACK COLOR INSULATION IS NOT ALLOWED.
- CONDUCTORS AT ALL TERMINATIONS SHALL BE MARKED TO INDICATE SOURCE PANEL, CIRCUIT NUMBER AND BRANCH LETTER. WIRING MARKERS SHALL BE CLIP-ON STYLE ACCORDING TO STANDARD SPECIFICATION 1066.07 (b). BUNDLE CONDUCTORS OF THE SAME BRANCH WITH WIRE TIES IN ALL JUNCTION BOXES AND HANDHOLES.
- . CONDUCTOR SPLICES SHALL BE COMPRESSION TYPE ACCORDING TO STANDARD SPECIFICATION 1066.06(c)(2) WITH WATERPROOF HEAT SHRINK COVER. SPLICES SHALL BE MADE WATERPROOF WITH HEAT SHRINK CAPPED SPLICE ACCORDING TO STANDARD SPECIFICATION 1066.06 (b).
- INSTALL LIGHT POLES PLUMB AND TRUE. HANDLE LIGHTING FIXTURES CAREFULLY TO PREVENT BREAKAGE, AND DAMAGE. DO NOT INSTALL DAMAGED LIGHTING FIXTURES. REPLACE AND RETURN DAMAGED UNITS TO EQUIPMENT MANUFACTURER.
- 10. AERIAL CABLE SHALL BE XLP ALUMINUM STRANDED CABLE ACCORDING TO THE STANDARD SPECIFICATIONS 1066.04. ALL AERIAL CABLE SHALL BE NEW AND UNUSED. PROVIDE TAGS ON CABLES TO DESIGNATED PHASE CONDUCTORS AND NEUTRAL CONDUCTOR.
- OVERHEAD ELECTRIC SERVICE DISCONNECT SWITCH SHALL COMPLY WITH STANDARD SPECIFICATION 1086.01(a)(3) AND CARRY UL SERVICE ENTRANCE LABEL. ELECTRIC SERVICE POLE SHALL BE CLASS 5 PER ARTICLE 804.02 NOTE 1.
- 12. ALL POLES, WHILE REFERRED TO AS TEMPORARY, ARE PERMANENT.
 CONTRACTOR SHALL TREAT THIS INSTALLATION AS A PERMANENT
 INSTALLATION.
- 13. NO WORK SHALL COMMENCE UNTIL TRAFFIC CONTROL REQUIREMENTS ARE
- 14. MAIL BOXES SHALL BE RELOCATED BY THE CONTRACTOR AS DIRECTED BY THE LOCAL POSTAL AUTHORITY. UNLESS INCLUDED AS A CONTRACT PAY ITEM, THIS WORK SHALL BE CONSIDERED INCIDENTAL TO THE CONTRACT.
- 15. ALL UTILITIES, SCHOOL DISTRICTS, LOCAL POLICE, AND FIRE DEPARTMENTS SHALL BE NOTIFIED BY THE CONTRACTOR PRIOR TO THE START OF CONSTRUCTION.
- 16. UNLESS AUTHORIZED BY THE ENGINEER, ALL EXISTING ACCESS POINTS SHALL BE MAINTAINED AT ALL TIMES BY THE CONTRACTOR. THE LOCATION AND ELEVATION OF EXISTING UTILITIES ARE APPROXIMATE AND ARE PROVIDED BY THE OWNERS. THE EXACT LOCATIONS AND ELEVATIONS ARE TO BE VERIFIED BY THE CONTRACTOR THROUGH THE OWNERS OF THE UTILITIES.
- 17. TRAFFIC CONTROL AND PROTECTION SHALL BE PERFORMED IN ACCORDANCE WITH THE TRAFFIC CONTROL PLAN, TRAFFIC SIGNAL PLANS, THESE NOTES, APPLICABLE SPECIAL PROVISIONS, AND SECTION 701 OF THE STANDARD SPECIFICATIONS AS AMENDED BY THE SPECIAL PROVISION FOR WORK ZONE TRAFFIC CONTROL (CHECK SHEET LRS 3).
- 18. ARROW BOARDS WILL BE REQUIRED WHEN IMPLEMENTING ALL LANE
- ALL PAY ITEMS SHALL BE IN ACCORDANCE WITH THE STANDARD SPECIFICATIONS OR INCLUDED SPECIALS.

	LIGHTING SUMMARY OF QUANTITIES								
SPECIAL PROVISION	PAY ITEM NO.	DESCRIPTION (IDOT PAY ITEM #)	UNIT	TOTAL QUANTITY					
	1	ELECTRIC SERVICE INSTALLATION (80400100)	EACH	1					
Х	2	ELECTRIC UTILITY SERVICE CONNECTION (80400200)	EACH	1					
	3	AERIAL CABLE, 2-1/C NO. 2 WITH MESSENGER WIRE (81800190)	FOOT	2,267					
	4	LIGHTING CONTROLLER, POLE MOUNTED, 240 VOLT, 60 AMP (82500310)	EACH	1					
	5	LIGHT POLE, WOOD, 50 FOOT, CLASS 4, WITH 15FT MAST ARM (83057295)	EACH	14					
Х	6	TRAFFIC CONTROL AND PROTECTION (SPECIAL)	L SUM	1					
Х	7	SPECIAL WASTE DISPOSAL (SPECIAL)	CU YD	120					
Х	8	LUMINAIRE, LED, ROADWAY (SPECIAL)	EACH	14					
Х	9	CLEARING AND GRUBBING (SPECIAL)	SQ YD	1,135					
Х	10	TREE REMOVAL (SPECIAL)	EACH	5					

DISTRICT 1 & HIGHWAY STANDARDS

BE-800	Т	EMPORARY LIGHT POLE DETAILS
825001	-04 L	IGHTING CONTROLLER POLE MOUNTED, 240V
830026	-01 T	EMPORARY ROADWAY LIGHTING
701001	-02 C	DFF-RD OPERATIONS, 2L, 2W, MORE THAN 15' (4.5M) AWAY
701006	-05	DFF-RD OPERATIONS, 2L, 2W, 15' (4.5M) TO 24' (600MM) FROM PAVEMENT EDGE
701201	-04 L	ANE CLOSURE, 2L, 2W, DAY ONLY, FOR SPEEDS > 45 MPH
701001	04 T	PAGEIC CONTROL DEVICES

PLAN SYMBOLS

AERIAL CABLE, 2-1/C NO. 2 WITH MESSENGER WIRE

LIGHT POLE, WOOD, 50 FOOT, CLASS 4 WITH
15FT MAST ARM AND LUMINAIRE, LED, ROADWAY

ELECTRIC SERVICE INSTALLATION, ELECTRIC UTILITY SERVICE CONNECTION, AND LIGHTING CONTROLLER, POLE MOUNTED, 240V, 60A

€ GUYWIRE OR DEADMAN ANCHOR

SCALE: N.T.S.

USER NAME = drelmer	DESIGNED -	TJS/DAR	REVISED -
	DRAWN -	SRL	REVISED -
PLOT SCALE = 2.0000 ' / In	CHECKED -	JDE	REVISED -
PLOT DATE = 4/18/2022	DATE -	04/11/22	REVISED -


HIGHWAY STANDARDS, GENERAL NOTES, SOQ	F.A. RTE	SECTION	COUNTY	TOTAL SHEETS	
DUPAGE COUNTY - FARVAN PARKWAY		22-00210-05-TL	DUPAGE	18	2
IIGHWAY STANDARDS, GENERAL NOTES, SOQ DUPAGE COUNTY – FABYAN PARKWAY SHEET 1 OF 1 SHEETS STA. TO STA.			CONTRACT NO.		
SHEET 1 OF 1 SHEETS STA. TO STA.		ILLINOIS FED. A	ID PROJECT		


			SCH	EDULE OF ELEC	CTRICAL ITEMS			
			1	2	4	5	7	8
	LOCATION		ELECTRIC	ELECTRIC	LIGHTING	LIGHT POLE	SPECIAL	LUMINAIRE,
			SERVICE	UTILITY	CONTROLLER	WOOD, 50 FOOT	WASTE DISPOSAL	LED,
			INSTALLATION	SERVICE	POLE MOUNTED	CLASS 4, WITH		ROADWAY
STRUCTURE NO.	STATION	OFFSET		CONNECTION	240V 60 AMP	15 FT MAST ARM		
			(EACH)	(EACH)	(EACH)	(EACH)	(CU YD)	(EACH)
PP-01	97+00.00	62' LT	1	1	1		8	
A01	97+60.00	40' LT				1	8	1
A02	99+00.00	40' LT				1	8	1
A03	100+50.00	40' LT				1	8	1
A04	101+85.00	40' LT				1	8	1
A05	103+50.00	56' LT				1	8	1
A06	105+25.00	56' LT				1	8	1
A07	107+00.00	56' LT				1	8	1
80A	108+75.00	56' LT				1	8	1
A09	110+60.00	56' LT				1	8	1
A10	112+40.00	56' LT				1	8	1
A11	114+25.00	56' LT				1	8	1
A12	116+05.00	56' LT				1	8	1
A13	117+82.00	56' LT				1	8	1
A14	119+62.00	56' LT				1	8	1
	TOTAL		1	1	1	14	120	14


Farnsworth GROUP
1011 WARRENVILLE ROAD, SUITE 375
LISLE, ILLINOIS 60532
(630) 296-5877 / info@f-w.com


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	DRAWN - SRL	REVISED -
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PLOT DATE = 4/18/2022	DATE - 04/11/22	REVISED -

SCHEDULE OF QUANTITIES	F.A. RTE.	SECTION	COUNTY	TOTAL SHEETS	SHEET NO.
DUPAGE COUNTY - FABYAN PARKWAY		22-00210-05-TL	DUPAGE	18	3
DOLAGE COOM!! - LADIAM TAIKWA!			CONTRAC	T NO.	
SCALE: N.T.S. SHEET 1 OF 2 SHEETS STA. TO STA.		ILLINOIS FED. A	ID PROJECT		

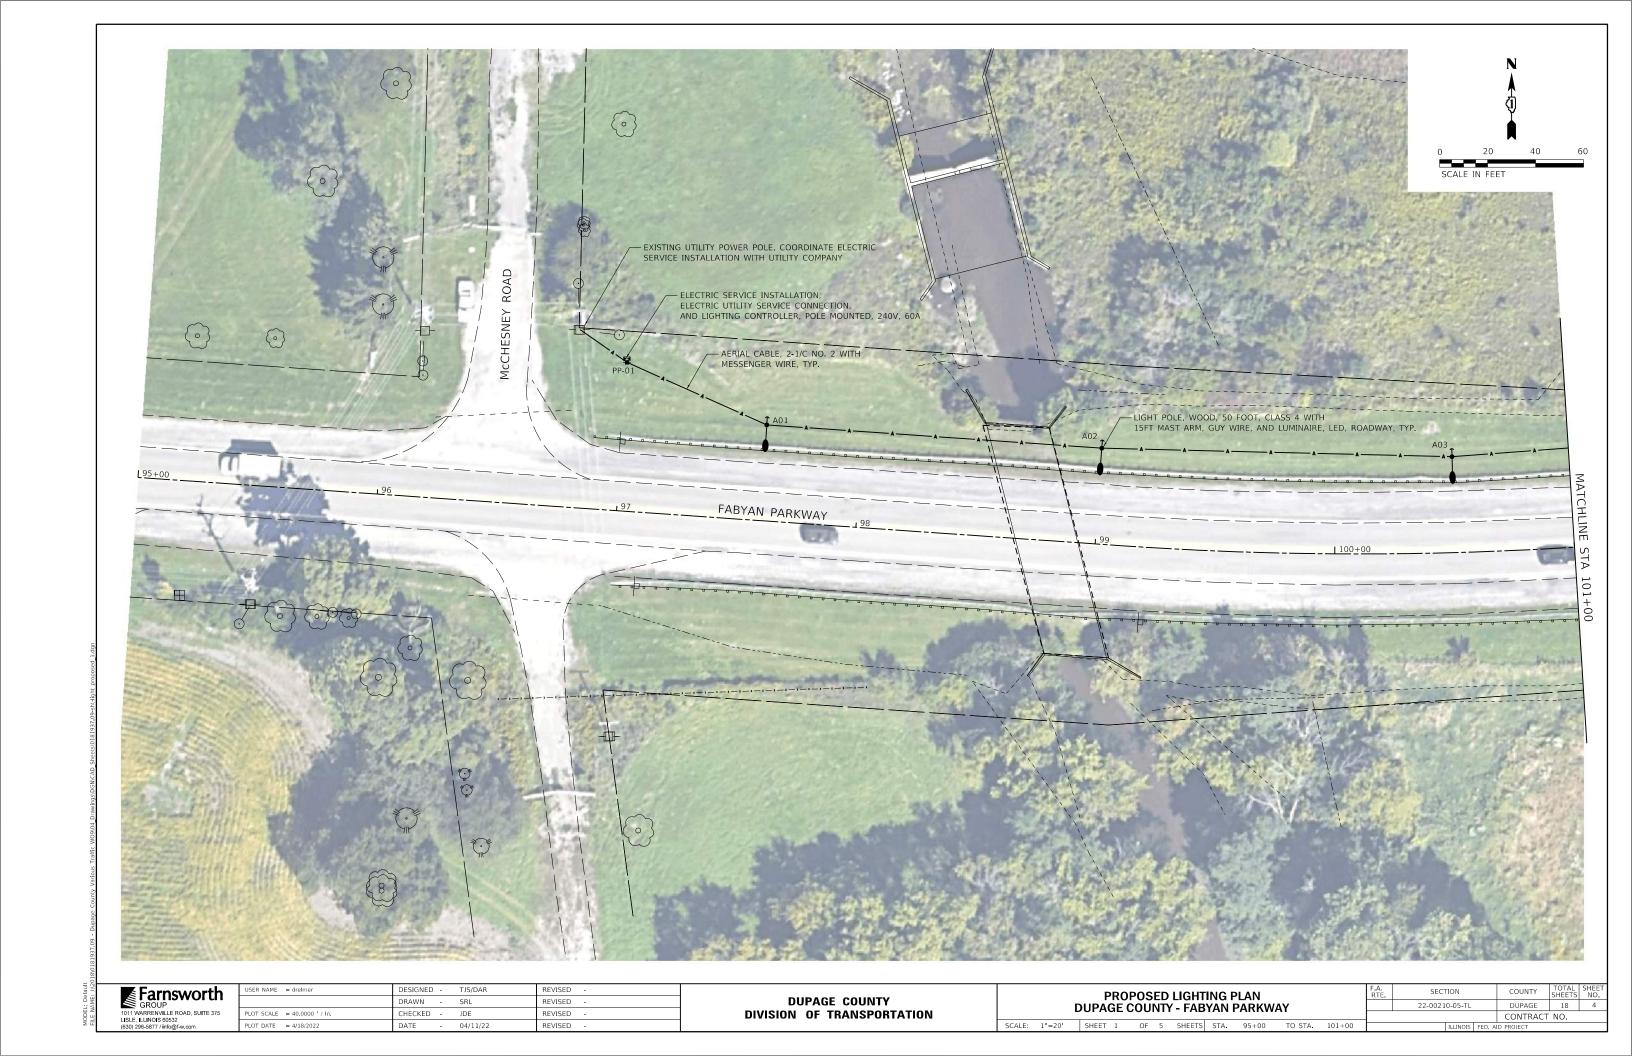

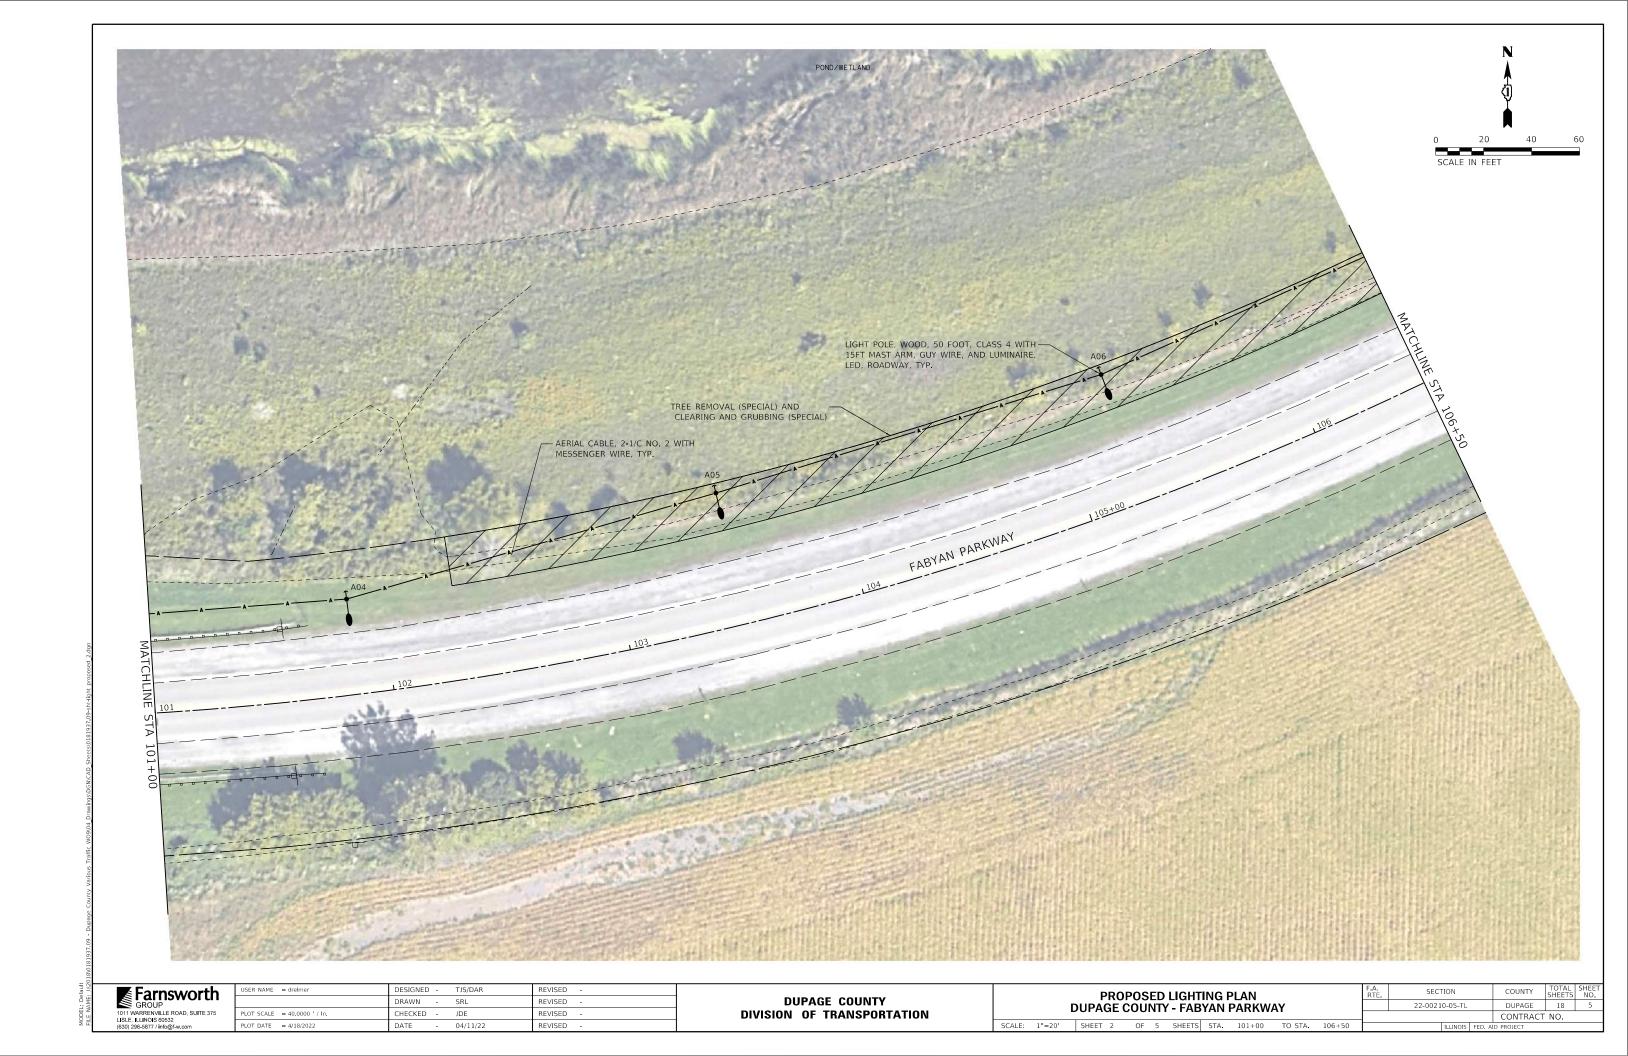

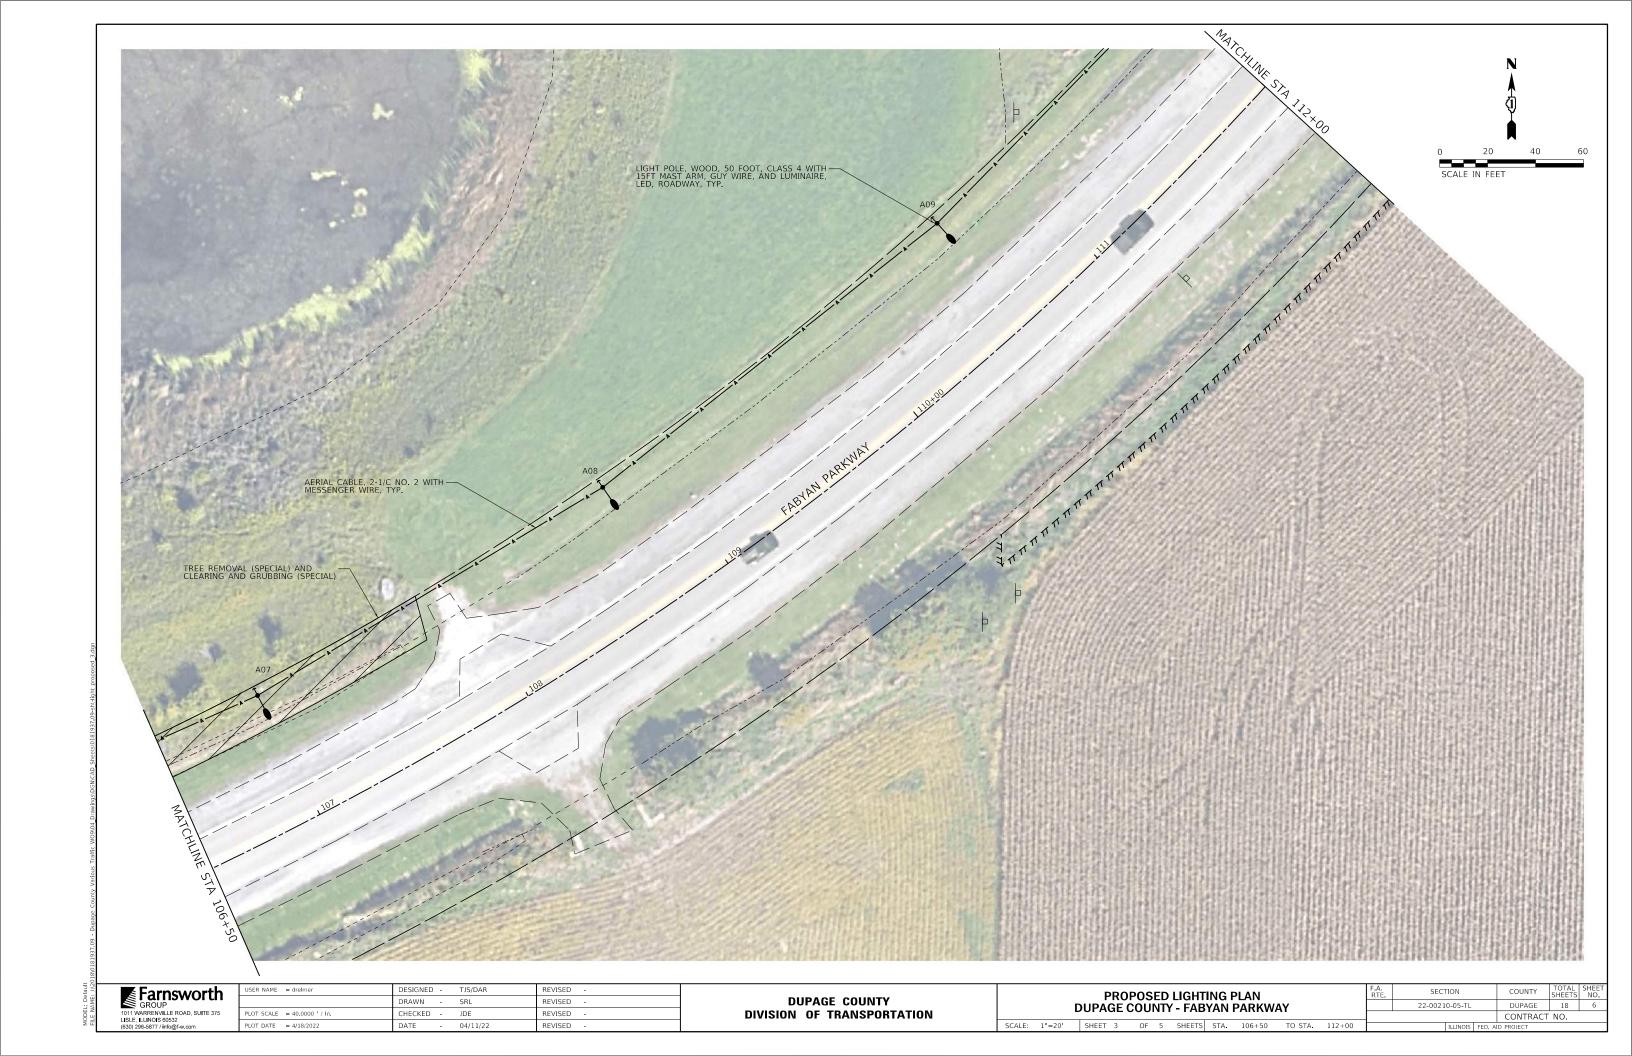


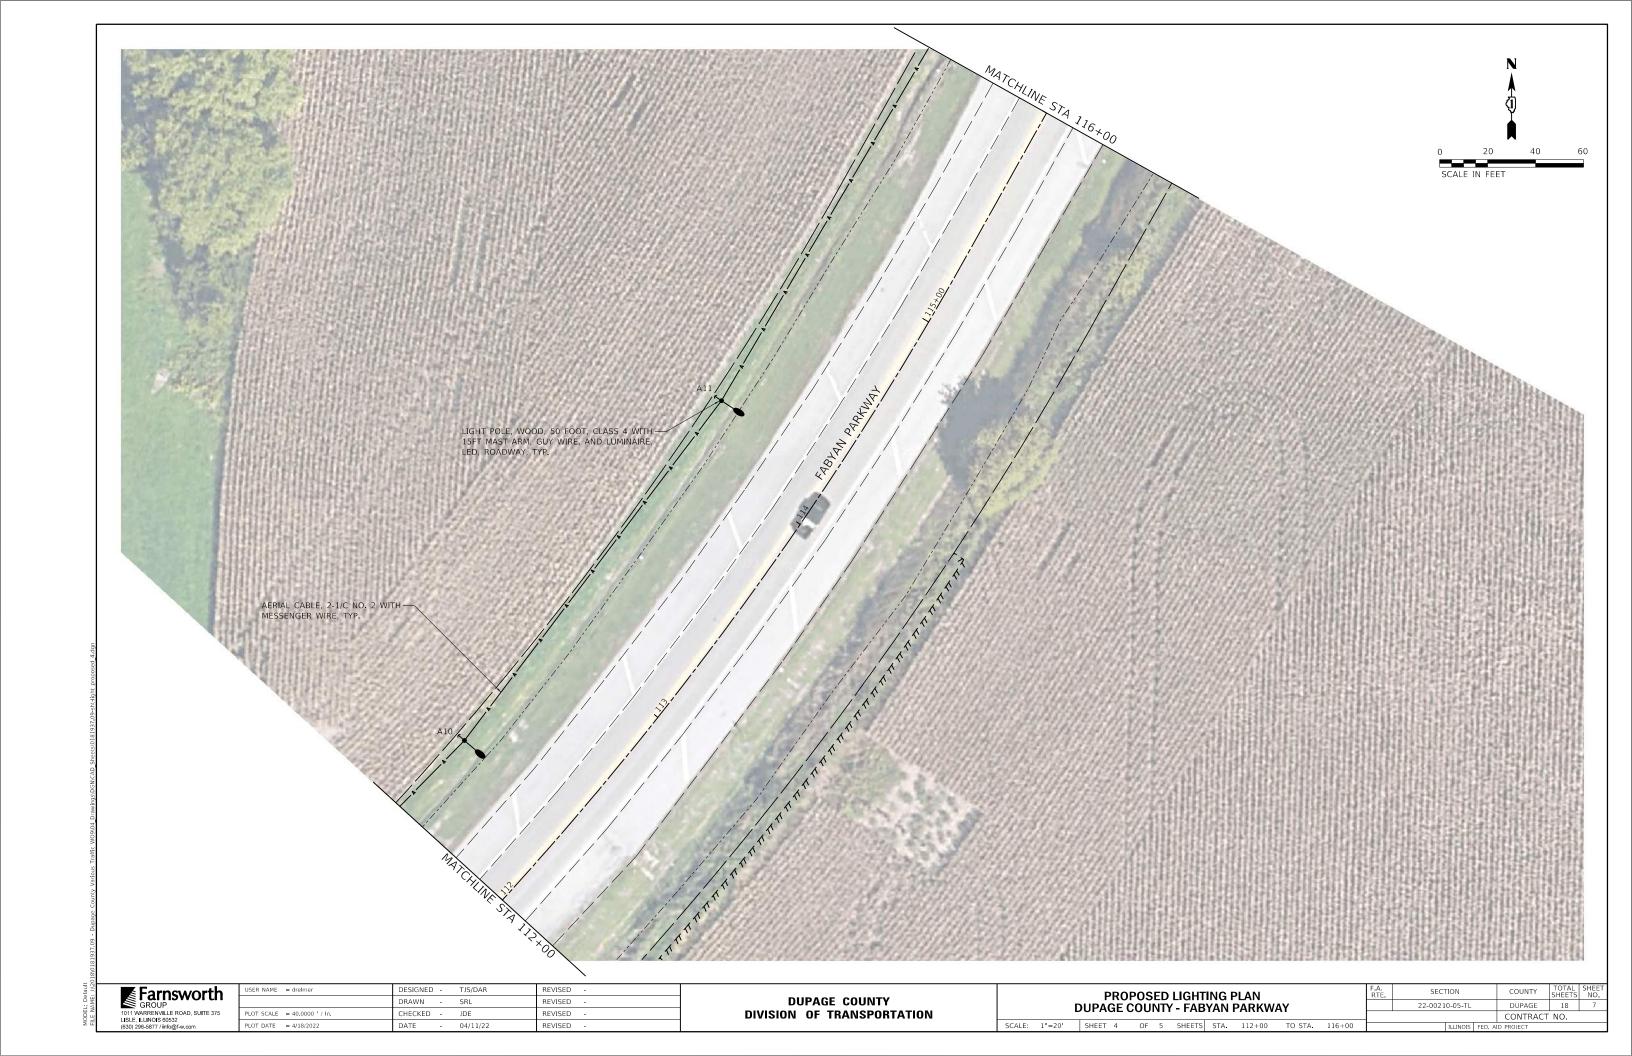



NOTES

- PROVIDE ELECTRIC UTILITY SERVICE 120/240V, SINGLE PHASE, 3-WIRE, 60A.
- 2. ALL CONDUCTORS SHALL BE AERIAL CABLE, 2-1/C NO. 2, WITH MESSENGER WIRE (PAY ITEM 81800190)
- 3. CIRCUIT LOAD: FIXTURE WATTAGE = 177W EACH TOTAL WATTAGE: 2,478W CIRCUIT CURRENT: 10.33A AT 240V

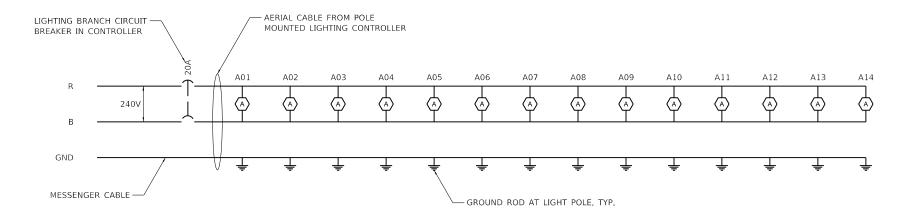

LIGHTING CIRCUIT DIAGRAM

Farnsworth	
GROUP	
1011 WARRENVILLE ROAD, SUITE 375	
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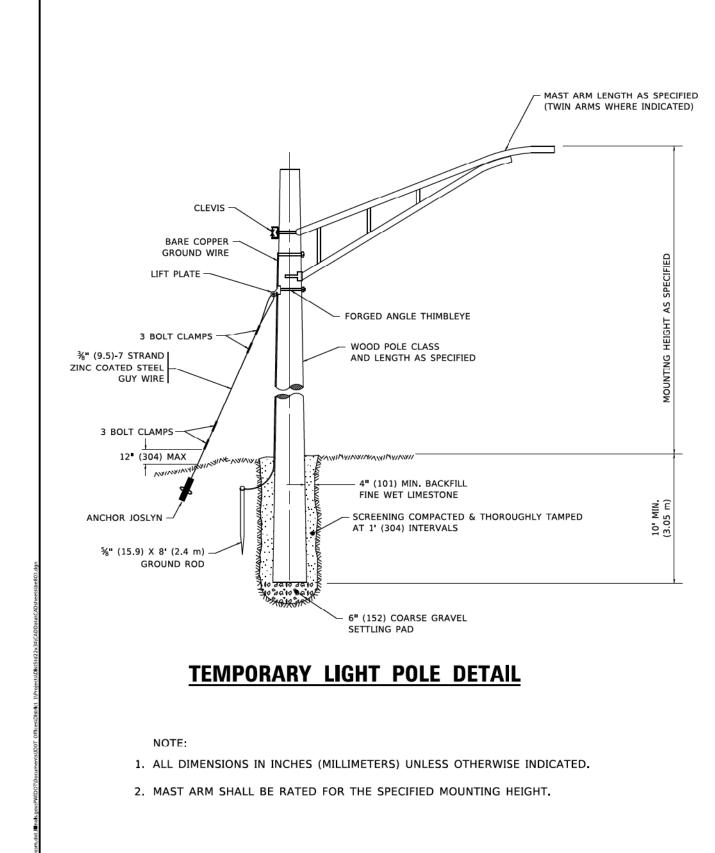
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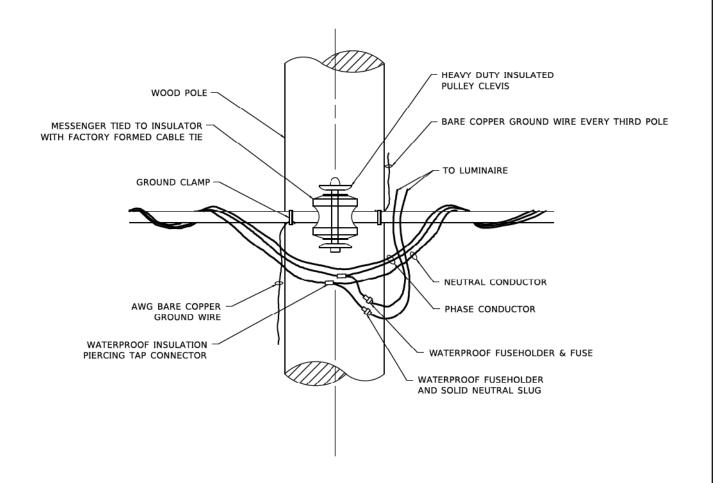
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DIVISION	0F	TR	ANSP	DRTATION	ı

SCALE: N.T.S

	LIGI	нті	NG	CI	RCUIT	DIA	GRAM	F.A RTE	SECTION		COUNTY	TOTAL SHEETS	SHEET NO.
וווח	DUPAGE COUNTY – FABYAN PARKWAY					22-00210-05-TL		DUPAGE	18	9			
DO:	OUTAGE COUNTY - TABIAN FARKWAT								CONTRAC [*]	ΓNO.			
	SHEET	1	OF	1	SHEETS	STA.	TO STA.		ILLINOIS	FED. AI	D PROJECT		

ounty Various Traffic WO9\04_Drawings\DGN\CAD_Sheets\0181937.09-sht-light Circuit D





TEMPORARY LIGHT POLE ATTACHMENT DETAIL

USER NAME = footemj	DESIGNED - DRAWN -	REVISED - 08-08-03 REVISED - R.T. 07-26-16	STATE OF ILLINOIS		TEMPORARY LIGHT PO	OLE DETAILS		F.A. RTE.	SECTION	COUNTY	TOTAL	SHEET NO.
PLOT SCALE = 50,0010 / In.	CHECKED -	REVISED -	DEPARTMENT OF TRANSPORTATION						BE-800	CONTRACT		
PLOT DATE = 4/19/2019	DATE -	REVISED -		SCALE: NONE	SHEET 1 OF 1 SHEETS	STA.	TO STA.			ID PROJECT		

day Cristalia and St FM Charlestonia	_
■ Farnsworth	
GROUP	
1011 WARRENVILLE ROAD, SUITE 375 LISLE, ILLINOIS 60532	F
(630) 296-5877 / info@f-w.com	Р


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	DRAWN - SRL	REVISED -
PLOT SCALE = 2.0000 / In	CHECKED - JDE	REVISED -
PLOT DATE = 4/18/2022	DATE - 04/11/22	REVISED -

DU	JPA (GE COUNTY	
DIVISION	0F	TRANSPORTATION	

DISTRICT 1 & HIGHWAY STANDARDS						SECT	TION	
DIIPAGE (DUPAGE COUNTY - FABYAN PARKWAY						0-05-TL	
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HEET 2	OF 10	SHEETS	STA	TO STA.			TELEMOTE	cer

RTE. SECTION				COUNTY	SHEETS	NO.
	22-0021	0-05-TL	DUPAGE	18	10	
			CONTRACT	NO.		
		ILLINOIS	ID PROJECT			

NAME: 1/2018/0181937.09 - Dupag

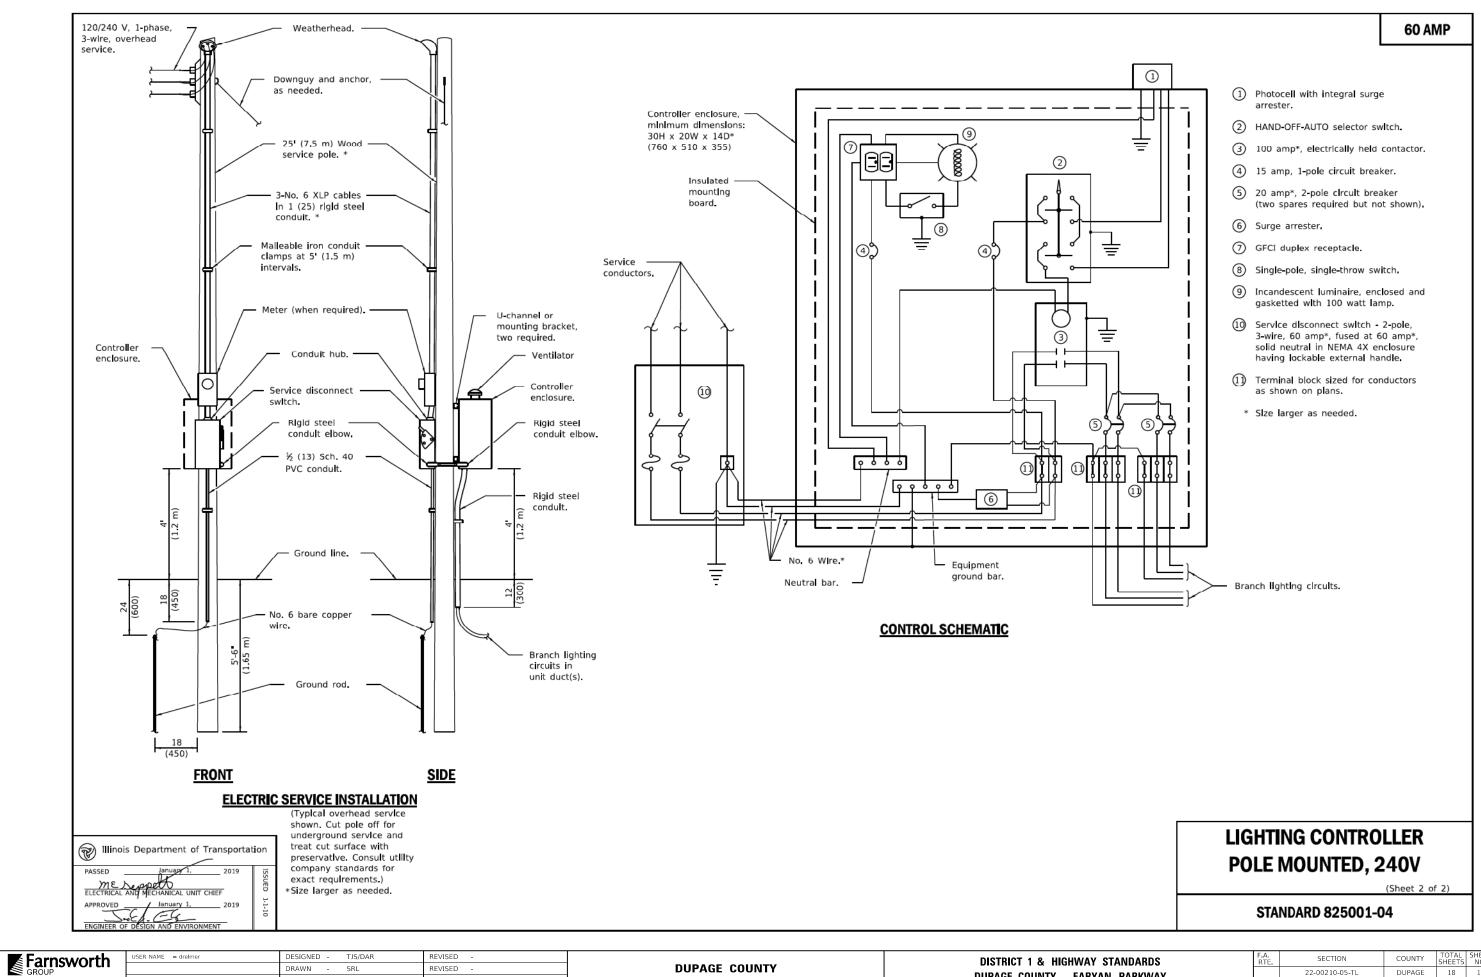


LISLE, ILLINOIS 60532 (630) 296-5877 / info@f-w.

DRAWN SRL REVISED HECKED -JDE REVISED PLOT DATE = 4/18/2022 DATE REVISED 04/11/22

DUPAGE COUNTY DIVISION OF TRANSPORTATION

DISTRICT 1 & HIGHWAY STANDARDS DUPAGE COUNTY - FABYAN PARKWAY SHEET 3 OF 10 SHEETS STA.

SECTION COUNTY 22-00210-05-TL DUPAGE 18 11 CONTRACT NO.

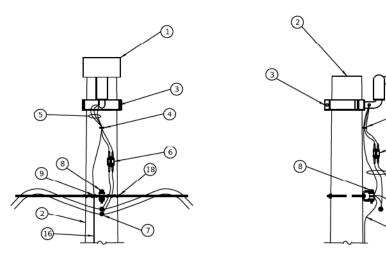




SIDE VIEW

LUMINAIRE **MOUNTING DETAILS**

43' - 44' (13.1 m - 13.4 m) mounting height unless noted otherwise on plans.

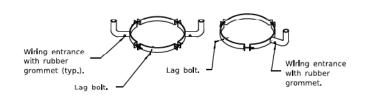


<u>TWIN</u>

Illinois Department of Transportation

SINGLE

MOUNTING BRACKET DETAILS

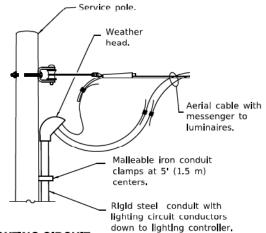

LIGHTING CIRCUIT AT SERVICE/CONTROLLER

See standard 825001 for service installation.



- Wood light pole, 50' (15.2 m), class 3 (typ.). *
- 3 Luminalre mounting bracket.
- (4) Cable clamps on 24 (600) centers.
- 5 Three #10 XLP-USE cable.
- 6 Waterproof, two-pole fuse holder with fuses.
- 7 Waterproof insulation piercing tap connector.
- 8 Heavy duty Insulated pulley clevIs with mounting bolt and hardware.
- Ground clamp.
- (1) 1 (25) rigid steel conduit. *
- (1) Malleable iron conduit clamps, 5' (1.5 m) Intervals.
- 1) Threaded condult reducer.
- (13) "C" condulet, threaded.
- 1½ (40) rigid steel condult. *
- 15 Conduit bushing.
- 16 #6 Bare copper ground wire to 10 ft. ground rod, every third light pole.
- ① Unit duct.
- 18 Wire tie.
- 19 Malleable iron conduit clamp below "C■ condulet.
- * Size larger as needed.

GENERAL NOTES

See plans for wire and unit duct sizes and pole locations not shown.

Provide guy wires with strain insulators and anchors, as needed.

All dimensions are in inches (millimeters) unless otherwise shown.

DATE	REVISIONS						
1-1-19	Revised Luminaire to be						
	horizontal.						
1-1-13	New standard.	H					

SCALE: N.T.S.

LIGHT POLE WITH CIRCUIT ROUTED

UNDERGROUND

3

Grade.

TEMPORARY ROADWAY LIGHTING

STANDARD 830026-01



USER NAME = drelmer	DESIGNED -	TJS/DAR	REVISED -
	DRAWN -	SRL	REVISED -
PLOT SCALE = 2,0000 ' / In.	CHECKED -	JDE	REVISED -
PLOT DATE = 4/18/2022	DATE -	04/11/22	REVISED -


DUPAGE COUNTY

						ANDARDS PARKWAY	
SHEET	4	OF	10	SHEETS	STA.	TO	O STA.

RTE SECTION				COUNTY	TOTAL SHEETS	SHEE
	22-0021	DUPAGE	18	12		
			CONTRACT	NO.		
		ILLINOIS	FED. AI	ID PROJECT		

Farnsworth


DIVISION OF TRANSPORTATION

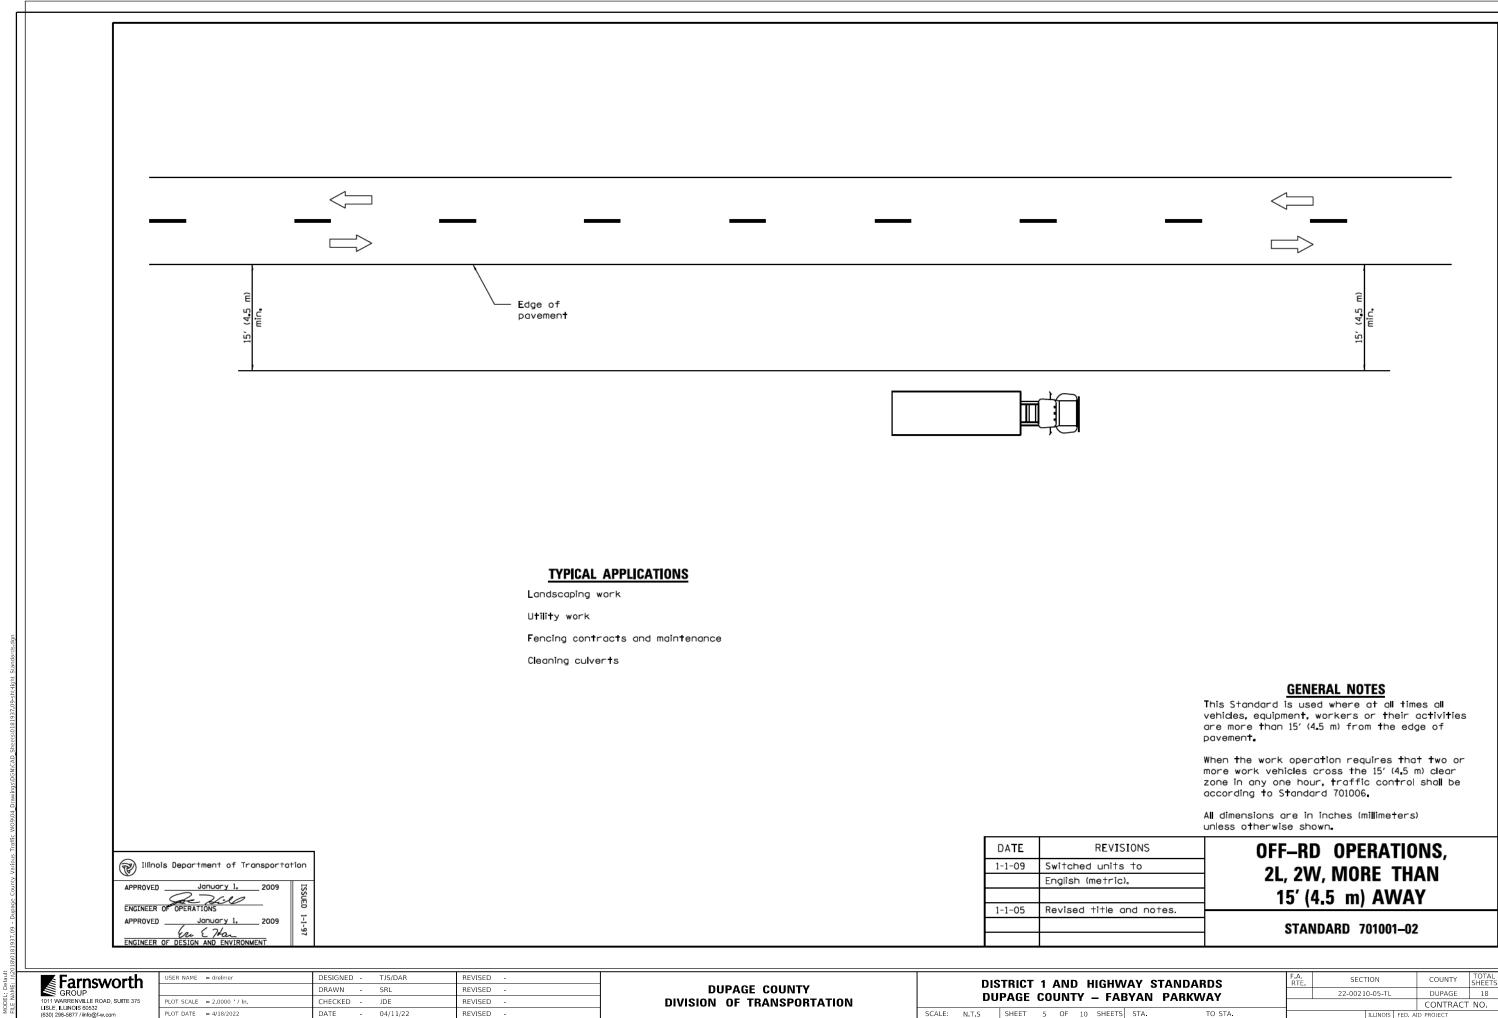

1011 WARRENVILLE ROAD, SUITE 375 LISLE, ILLINOIS 60532 (630) 296-5877 / info@f-w.com

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PLOT SCALE = 2,0000 ' / In.	CHECKED	-	JDE	REVISED -
PLOT DATE = 4/18/2022	DATE	-	04/11/22	REVISED -

DUPAGE 18 13

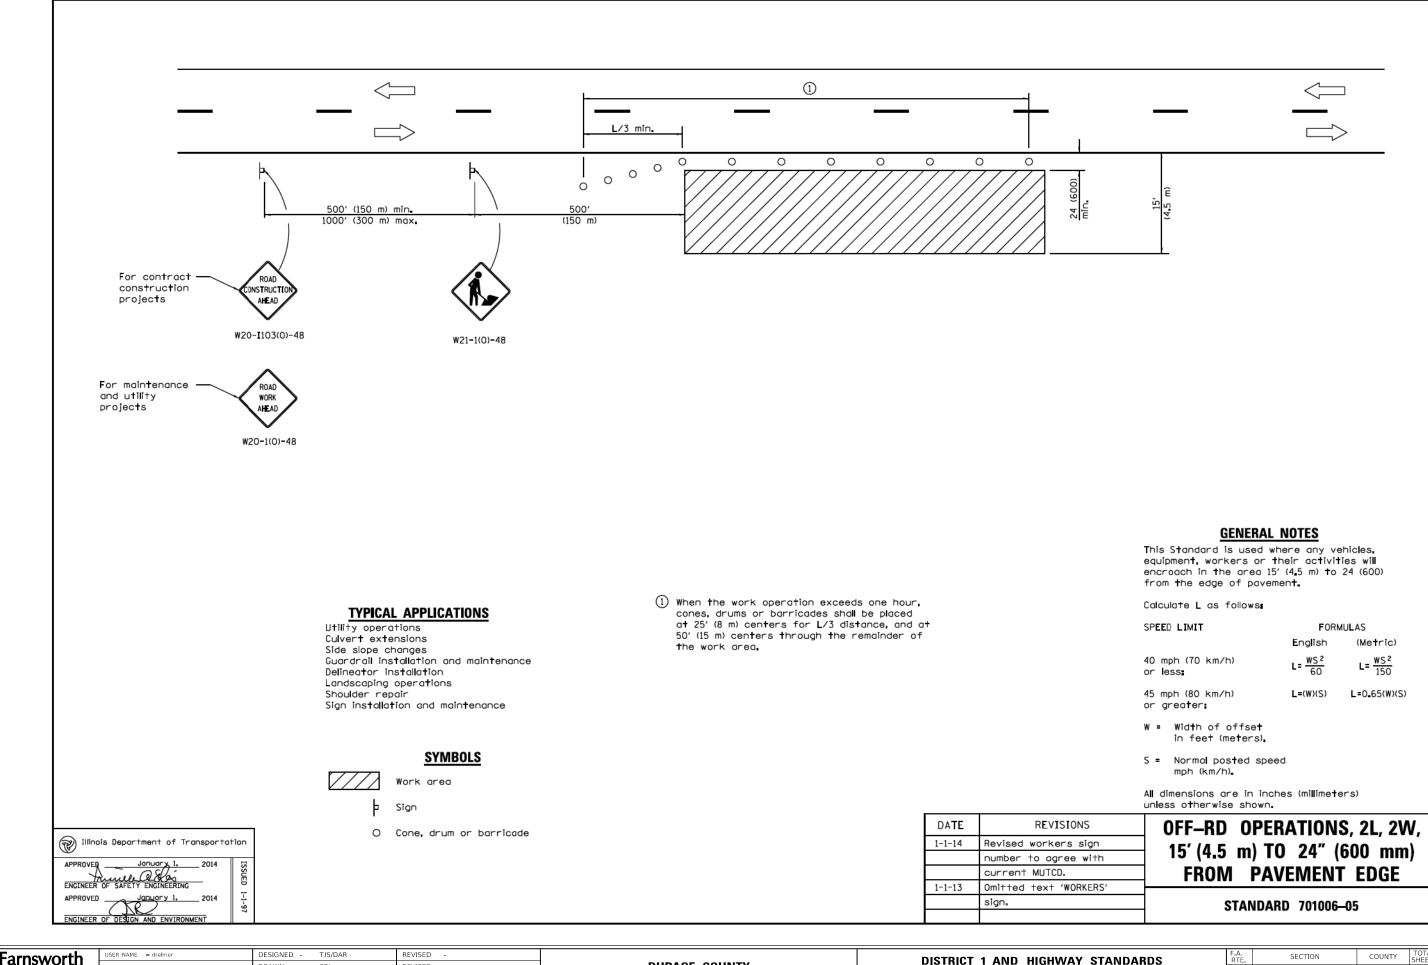

MODEL; Default

Farnsworth
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DUPAGE COUNTY DIVISION OF TRANSPORTATION


DISTRICT 1 AND HIGHWAY STANDARDS DUPAGE COUNTY – FABYAN PARKWAY

SCALE: N.T.S SHEET 6 OF 10 SHEETS STA. TO STA

F.A. SECTION COUNTY TOTAL SHEETS NO.

22-00210-05-TL DUPAGE 18 14

CONTRACT NO.

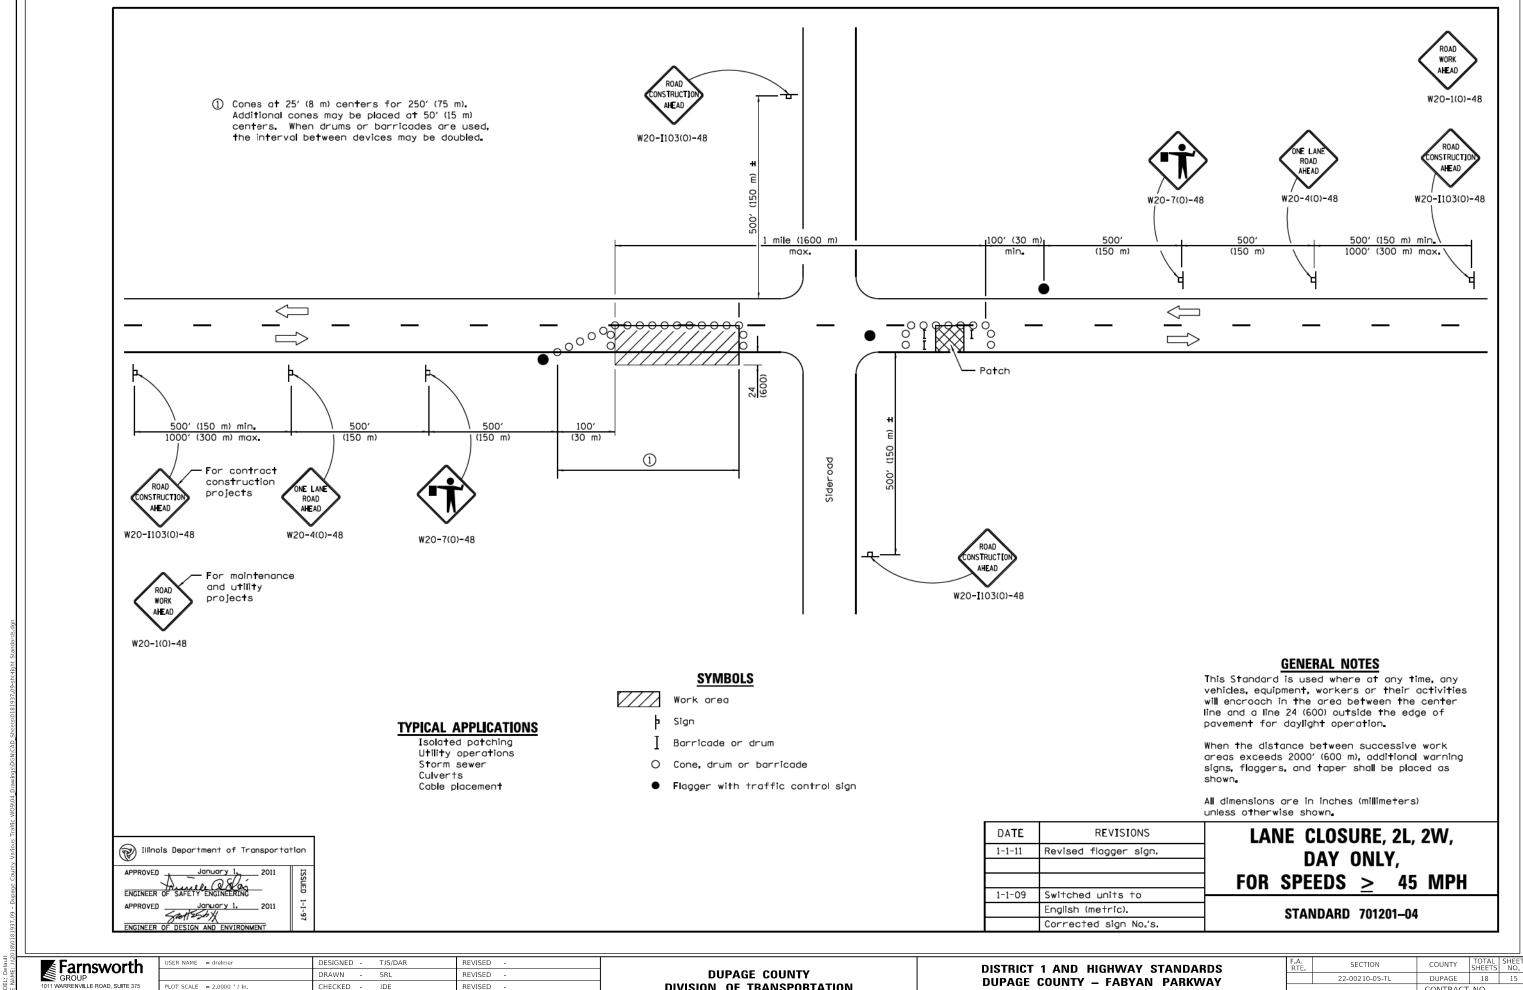


LISLE, ILLINOIS 60532 (630) 296-5877 / info@f-w.c

JDE REVISED REVISED PLOT DATE = 4/18/2022 DATE

DIVISION OF TRANSPORTATION

SCALE: N.T.S SHEET 7 OF 10 SHEETS STA.

CONTRACT NO.

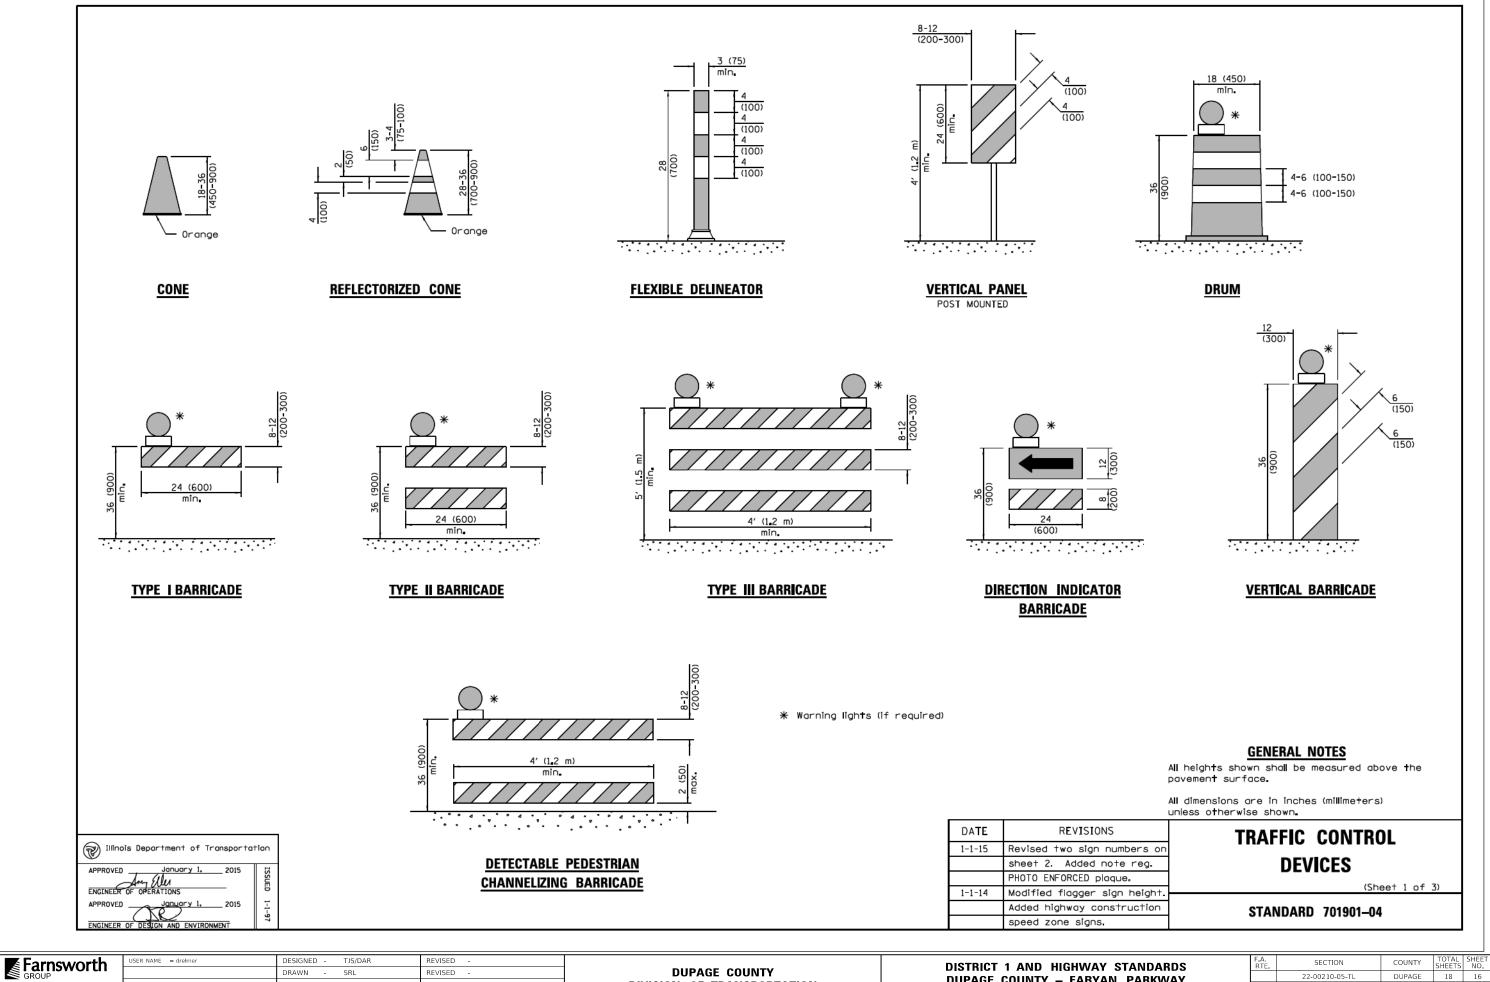


1011 WARRENVILLE ROAD, SUITE 375 LISLE, ILLINOIS 60532 (630) 296-5877 / info@f-w.com

PLOT SCALE = 2,0000 ' / In. REVISED PLOT DATE = 4/18/2022 DATE REVISED 04/11/22

DIVISION OF TRANSPORTATION


DUPAGE COUNTY - FABYAN PARKWAY SCALE: N.T.S SHEET 8 OF 10 SHEETS STA.

DUPAGE 18 16 22-00210-05-TL CONTRACT NO.

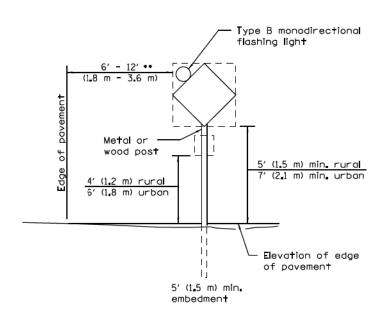


POST MOUNTED SIGNS

•• When curb or paved shoulder are present this dimension shall be 24 (600) to the face of curb or 6' (1.8 m) to the outside edge of the paved shoulder.

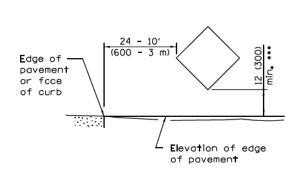

SIGNS ON TEMPORARY SUPPORTS

••• When work operations exceed four days, this dimension shall be 5' (1.5 m) min. If located behind other devices, the height shall be sufficient to be seen completely above the devices.

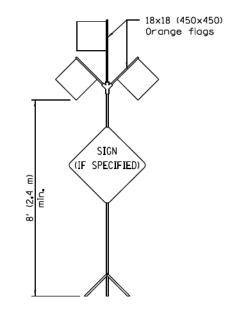

HIGH LEVEL WARNING DEVICE

ROAD CONSTRUCTION NEXT X MILES

END CONSTRUCTION

G20-I104(0)-6036

G20-I105(0)-6024


This signing is required for all projects 2 miles (3200 m) or more in length.

ROAD CONSTRUCTION NEXT X MILES sign shall be placed 500' (150 m) in advance of project limits.

END CONSTRUCTION sign shall be erected at the end of the job unless another job is within 2 miles (3200 m).

Dual sign displays shall be utilized on multilane highways.

WORK LIMIT SIGNING

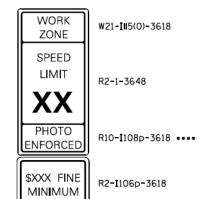

Sign assembly as shown on Standards or as allowed by District Operations.



This sign shall be used when the above sign assembly is used.


HIGHWAY CONSTRUCTION SPEED ZONE SIGNS

**** R10-I108p shall only be used along roadways under the juristiction of the State.

TRAFFIC CONTROL **DEVICES**

(Sheet 2 of 3)

STANDARD 701901-04

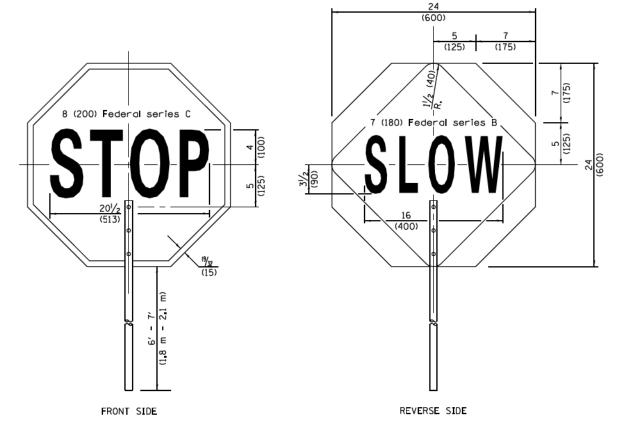

Illinois Department of Transportation

FLAGGER TRAFFIC CONTROL SIGN


Farnsworth GROUP LISLE, ILLINOIS 60532 (630) 296-5877 / info@f-w

R NAME = drelmer	DESIGNED -	-	TJS/DAR	REVISED -
	DRAWN -	-	SRL	REVISED -
T SCALE = 2.0000 ' / In	CHECKED -	-	JDE	REVISED -
T DATE = 4/18/2022	DATE -		04/11/22	REVISED -

DUPAGE COUNTY DIVISION OF TRANSPORTATION

DISTRICT 1 AND HIGHWAY STANDARDS DUPAGE COUNTY - FABYAN PARKWAY SCALE: N.T.S SHEET 9 OF 10 SHEETS STA.

A RTE	SECTION			COUNTY	TOTAL SHEETS	SHEET NO.
	22-00210-05-TL			DUPAGE	18	17
				CONTRACT NO.		
	ILLINOIS FED AID PROJECT					

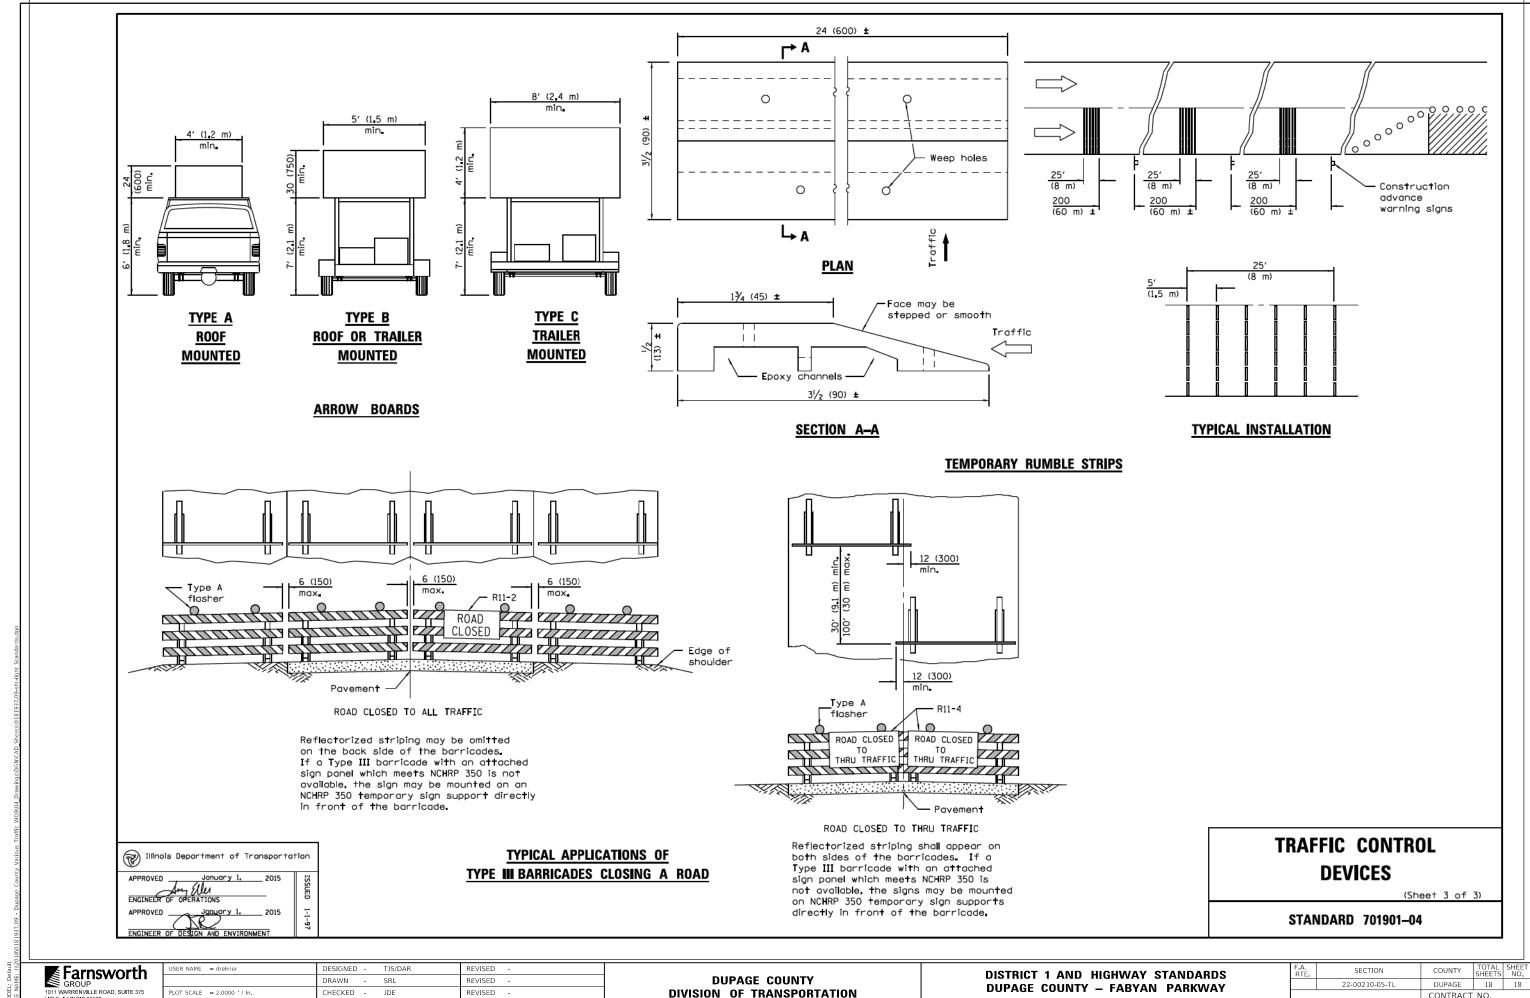

LISLE, ILLINOIS 60532 (630) 296-5877 / info@f-w REVISED

SCALE: N.T.S SHEET 10 OF 10 SHEETS STA.

CONTRACT NO.